ADDENDUM NO. 1 CAMPUS WIDE EXTERIOR LIGHTING UPGRADES TENNESSEE TECHNOLOGICAL UNIVERSITY

SBC No. 364/011-08-2021 September 10, 2025

The original construction documents dated August 18,2025, are hereby amended as described hereinafter. All bidders shall acknowledge receipt of Addendum No. 1 in the Bid Form.

1. Refer to Drawings: Replace Drawings E0.1, E2.2, E3.1, E6.1, and E7.1 currently in the bid documents with attached Revision # 1 Drawings E0.1, E2.2, E3.1, E6.1, and E7.1 dated 9-10-25.

END OF ADDENDUM NO. 1



-		T	NATION						ring fixture			1			
ILLUMINATION				MOUNTING CEILING WALL											
DESIGNATION	WATTS	DELIVERED LUMENS	COLOR TEMPERATURE (*K)	MINIMUM CRI		ІСТН	SURFACE		HEIGHT ABOVE FINISHED FLOOR OR GRADE	DESCRIPTION: SHIELDING, TYPE MATERIALS, FINISH, MOUNTING	PROD	ACTURER'S UCT ITEM		DUCT ITTED	APPROVED EQUAL MANUFACTURES
	*		ŏ	Σ	S	เร	꾼	불교		COMPANY	CATALOG NO.	YES	NO		
A1	140	18,000	4000	80		•			WALL MOUNTED FULL CUTOFF TRAPEZOIDAL FIXTURE, LARGE PROFILE, BLACK FINISH, FORWARD THROW OPTICS	LITHONIA	WDGE4-LED- P4-40K- 80CRI-R4- MVOLT-SRM- DBLXD	•		MCGRAW EDISON GARDCO	
42	15	2000	4000	80		•			WALL MOUNTED FULL CUTOFF TRAPEZOIDAL FIXTURE, MEDIUM PROFILE, BLACK FINISH, FORWARD THROW OPTICS, BUILT-IN BATTERY PACK	LITHONIA	WDGE2-LED- P2-40K- 80CRI-VF- MVOLT-E4WH- DBLXD	•		MCGRAW EDISON GARDCO	
43	10	1200	4000	80		•			WALL MOUNTED FULL CUTOFF TRAPEZOIDAL FIXTURE, SMALL PROFILE, BLACK FINISH, FORWARD THROW OPTICS, BUILT—IN BATTERY PACK	LITHONIA	WDGE1-LED- P1-40K- 80CRI-VF- MVOLT-E4WH- DBLXD	•		MCGRAW EDISON GARDCO	
44	13	1500	4000	80		•			EXISTING WALL SCONCE TO REMAIN, CLEAN AND RELAMP WITH LED "A" LAMP	_	_				
45	20	1500	4000	80		•			WALL MOUNTED EXTERIOR CYLINDER, DOWNLIGHT COMPONENT ONLY, BLACK FINISH, TYPE 2 DISTRIBUTION	LIGMAN	UTA-31861- 20W-T2-W40- 01-120/277V-			H.E. WILLIAMS PORTFOLIO KIRLIN	
В	15.6	2000	4000	80		•			2×2 LOW PROFILE SURFACE UNDERCANOPY LIGHT, DAMP LOCATION LISTED, SURFACE MOUNTING KIT	LITHONIA	CPX 2X2- 2000LM- 80CRI-40K- SWL-MIN10- MVOLT-2X2 SMKSH	•		COLUMBIA H.E. WILLIAMS	
С	_	_	4000	80		•			DECORATIVE LANTERN, SEE DECORATIVE LANTERN SCHEDULE ON THIS DRAWING FOR ADDITIONAL INFORMATION						
D	15.7	1500	4000	80		•			UNDER EAVE MOUNTED CYLINDER, 4" DIAMETER, 5 13/16" DEEP, WET LOCATION LISTED, WHITE FINISH AT DERRYBERRY, BLACK FINISH AT UNIVERSITY SERVICES	GOTHAM	IVO4CYL-SC- D-15LM-40K- 80CRI-WD- MIN10-MVOLT- ZT-L5-JBX- WL-P-AR-LSS- DWH/DBL	•		KIRLIN PORTFOLIO OMEGA	
E	13	1500	4000	80		•			COMPACT WALL UNIT ON METAL SIDING SYSTEM, DARK BRONZE FINISH, 5.5" WIDTH MAXIMUM, FIELD ADJUSTABLE COLOR TEMPERATURE	LITHONIA	WPXO-LED- ALO4-SWW2- MVOLT-PE- DDBXD	•		MCGRAW EDISON GARDCO	
F	20.3	2000	4000	80		•			UNDERCANOPY LIGHT, 15" SQUARE, SURFACE MOUNT, BLACK FINISH, MARINE GRADE DIE CAST ALUMINUM HOUSING	KENALL	MS150-PP- MB-15L40K- DV	•		MCGRAW EDISON GARDCO	

SITE POLE LIC									LE LIGHTING	FIXTU	RE SC	CHEDUI	Œ												
	ILLUMINATION POLE						DLE																		
DESIGNATION		RED LUMENS	: TEMPERATURE										WON	WON	WON	WON		SCR MATE SHA	IPTI ERIA APE,	ABOVE D GRADE	DESCRIPTION: SHIELDING, TYPE MATERIALS, FINISH, MOUNTING		MANUFACTURER'S PRODUCT ITEM	5	APPROVED EQUAL MANUFACTURES
DESIG	WATTS	DELIVERED	COLOR	ALUMINUM	STEEL	ROUND	SQUARE	HEIGH FINISH		COMPANY	POLE CATALOG NO.	LUMINAIRE CATALOG NO.													
SA	165 (2)	20,000 (2)	4,000	•		•		25'-0''	POLE MOUNTED AREA LIGHT, TWO LUMINAIRES MOUNTED 180 DEGREES APART, FULL CUTOFF TYPE 4 FORWARD THROW OPTICS, BLACK FINISH, PROVIDE 5 PIN PHOTOCELL CONNECTOR AND PROGRAM TO BE CONTROLLED BY EXISTING TTU CAMPUS UBICQUIA CONTROL SYSTEM	LITHONIA	RTA-5E- DM28AS- DBLXD-FBC	DSXLED-P6- 40K-80CRI- T4M-MVOLT- RPA-DBLXD	MCGRAW EDISON GARDCO												
SB	165	20,000	4,000	•		•		25'-0''	SAME AS TYPE "SA" FIXTURE, EXCEPT WITH JUST ONE LUMINAIRE	LITHONIA	RTA-5E- DM19AS- DBLXD-FBC	DSXLED-P6- 40K-80CRI- T4M-MVOLT- RPA-DBLXD	MCGRAW EDISON GARDCO												
SC	135	15,000	4,000	•		•		12'-0''	DECORATIVE POST TOP PEDESTRIAN LUMINAIRE WITH INTEGRAL TOP PIECE TO LIMIT "UPLIGHT", BLACK FINISH, PROVIDE 5 PIN PHOTOCELL CONNECTOR AND PROGRAM TO BE CONTROLLED BY EXISTING TTU CAMPUS UBICQUIA CONTROL SYSTEM	GLOBAL GREEN (FIXTURE) HOLOPHANE (POLE)	HOLOPHANE ABGBK	GLOBAL GREEN LPT-AGN- 135-47- UDP-PT-FC2	HOLOPHANE GRANVILLE KING MARION SERIES PHILLIPS HADCO RL												
SD	165 (2)	20,000 (2)	4,000	•		•		25'-0''	SAME AS TYPE "SA" FIXTURE, EXCEPT WITH TWO LUMINAIRES MOUNTED 90 DEGREES APART	LITHONIA	RTA-5E- DM29AS- DBLXD-FBC	DSXLED-P6- 40K-80CRI- T4M-MVOLT- RPA-DBLXD	MCGRAW EDISON GARDCO												
SE	165 (3)	20,000 (3)	4,000	•		•			SAME AS TYPE "SA" FIXTURE, EXCEPT WITH THREE LUMINAIRES MOUNTED 120 DEGREES APART	LITHONIA	RTA-5E- DM32AS- DBLXD-FBC	DSXLED-P6- 40K-80CRI- T4M-MVOLT- RPA-DBLXD	MCGRAW EDISON GARDCO												
SF	135	15,000	4,000	•		•		15'-0''	SAME AS TYPE "SC" FIXTURE, EXCEPT USE 15'-0" POLE INSTEAD OF 12'-0" POLE																

WHERE NEW UNDERGROUND WIRING IS SHOWN, IT SHALL BE INSTALLED AT A MINIMUM BURIAL

DEPTH OF 24" BELOW FINISHED GRADE. CONTRACTOR SHALL VERIFY ROUTINGS OF ALL NEW UNDERGROUND WIRING RUNS PRIOR TO INSTALLATION. WIRING ROUTING LOCATIONS SHOWN ON

ALL AREAS IMPACTED BY NEW UNDERGROUND WIRING SERVING NEW POLE MOUNTED LIGHTING

FIXTURES SHALL BE RESTORED TO THEIR PRE-CONSTRUCTION STATE AS REQUIRED. REFER TO

WHERE NEW BUILDING MOUNTED LIGHTING FIXTURES ARE SHOWN REPLACING EXISTING BUILDING

MOUNTED LIGHTING FIXTURES, CONTRACTOR SHALL PROVIDE ALL REQUIRED "TOUCH-UP" WORK TO

RESTORE AFFECTED AREAS TO THEIR PRE-CONSTRUCTION STATES. THIS SHALL INCLUDE, BUT NOT

PROJECT MANUAL SECTION 26 07 00, "EXCAVATION AND BACKFILLING" FOR ADDITIONAL

CONTRACTOR SHALL PROVIDE UPDATED TYPEWRITTEN CIRCUIT DIRECTORIES IN EXISTING

LIMITED TO, PATCHING AND PAINTING OF EXISTING WALLS AS REQUIRED.

PANELBOARDS THAT SERVE NEW POLE MOUNTED LIGHTING CIRCUITS.

GENERAL INSTALLATION NOTES:

DRAWINGS ARE DIAGRAMMATIC ONLY.

L E G E N D

DESCRIPTION

SYMBOL

DUPLEX PLUG RECEPTACLE, 120-VOLTS, 20-AMPERES, SHADED CENTER INDICATES EQUIPPED WITH BUILT-IN GROUND FAULT CIRCUIT INTERRUPTER, MOUNT 3"

ABOVE BACKSPLASH AT WORK COUNTERS/LAVATORIES AND +18" AFF ELSEWHERE UNLESS NOTED TO A DIFFERENT HEIGHT. PROVIDE WEATHER RESISTANT DEVICE AND WEATHERPROOF "EXTRA DUTY WHILE IN USE" COVER WHERE LOCATED OUTDOORS. TAMPER RESISTANT, UNLESS NOT REQUIRED BY CODE.

PANELBOARD, RECESSED OR SURFACE MOUNTED AS INDICATED ON DRAWINGS,
TOP 6-FEET ABOVE FINISHED FLOOR ADJUSTED TO OCCUR AT A MASONRY
JOINT, SEE PANELBOARD SCHEDULE FOR EQUIPMENT CONTAINED.

CONDUIT IN THE FLOOR CONSTRUCTION OR UNDERGROUND SHOWN TURNING UP.

HOMERUN CIRCUIT WIRING TO EXISTING PANELBOARD, NOTATION "3(20/1)"
INDICATES HOMERUN WIRING TO BE CONNECTED TO THREE 20/1 CIRCUIT
BREAKERS IN EXISTING PANELBOARD. CROSS LINES INDICATES THE NUMBER OF
#12 AWG PHASE AND NEUTRAL CONDUCTORS WHERE MORE THAN TWO. SINGLE
CIRCUIT BRANCH CIRCUIT WIRING RUNS SHOWN WITHOUT CROSS LINES SHALL
BE PROVIDED WITH 2#12, 1#12G. EACH 20 AMPERE BRANCH CIRCUIT SHALL BE
PROVIDED WITH SEPARATE NEUTRAL CONDUCTOR. SHARING OF NEUTRAL
CONDUCTORS SHALL NOT BE PERMITTED. PROVIDE EQUIPMENT GROUNDING
CONDUCTOR IN EACH CONDUIT RUN.


POLE MOUNTED LIGHTING FIXTURE, SEE SITE LIGHTING FIXTURE AND SITE PLANS FOR ADDITIONAL INFORMATION.

BUILDING MOUNTED LIGHTING REPLACEMENT KEYED NOTES: $(\langle \# \rangle)$

- 1. REMOVE EXISTING LIGHTING FIXTURE AND REPLACE WITH NEW LIGHTING FIXTURE. CONNECT NEW LIGHTING FIXTURE TO EXISTING WIRING SERVING LIGHTING FIXTURE BEING REMOVED. CALL ANY EXISTING WIRING DEFICIENCIES THAT ARE UNCOVERED TO ATTENTION OF ENGINEER PRIOR TO PROCEEDING WITH WORK.
- 2. FURNISH AND INSTALL NEW LIGHTING FIXTURE AT LOCATION WHERE NO EXISTING LIGHTING FIXTURE IS PRESENTLY INSTALLED. PROVIDE NEW BRANCH CIRCUIT WIRING TO THIS LIGHTING FIXTURE AS REQUIRED. FIXTURE SHALL BE CONNECTED TO EXISTING LINE VOLTAGE CIRCUIT SERVING OTHER EXTERIOR LIGHTING FIXTURES IN THIS VICINITY. NEW WIRING SHALL BE INSTALLED IN A NEAT AND WORKMANLIKE MANNER, RUN PARALLEL OR PERPENDICULAR TO BUILDING STRUCTURAL ELEMENTS. NEW WIRING SHALL BE RUN CONCEALED INSIDE THE BUILDING TO THE MAXIMUM EXTENT PRACTICABLE. WHERE EXPOSED WIRING IS NECESSARY DUE TO EXISTING BUILDING STRUCTURAL CONDITIONS, CONTRACTOR SHALL HAVE PROPOSED ROUTING OF EXPOSED WIRING APPROVED IN ADVANCE OF INSTALLATION BY ENGINEER.
- 3. FURNISH AND INSTALL NEW LIGHTING FIXTURE AT LOCATION SHOWN. AT THIS LOCATION, A LIGHTING FIXTURE WAS AT ONE TIME INSTALLED. AT SOME TIME IN PAST, LIGHTING FIXTURE WAS REMOVED AND A BLANK COVERPLATE WAS INSTALLED OVER THE JUNCTION BOX. UTILIZE EXISTING WIRING IN PLACE AT THIS EXISTING JUNCTION BOX TO SERVE NEW LIGHTING FIXTURE. CALL ANY EXISTING WIRING DEFICIENCIES THAT ARE UNCOVERED TO ATTENTION OF ENGINEER PRIOR TO PROCEEDING WITH WORK.
- 4. REMOVE TWO(2) EXISTING LIGHTING FIXTURES AND REPLACE WITH ONE(1) NEW LIGHTING FIXTURE AT LOCATION INDICATED. CONNECT NEW LIGHTING FIXTURE TO EXISTING WIRING SERVING LIGHTING FIXTURE BEING REMOVED. CALL ANY EXISTING WIRING DEFICIENCIES THAT ARE UNCOVERED TO ATTENTION OF ENGINEER PRIOR TO PROCEEDING WITH WORK.
- REMOVE EXISTING WALL MOUNTED LIGHTING FIXTURE LOCATED ABOVE CANOPY. INSTALL BLANK COVERPLATE OVER J.BOX.
- 6. AT LOCATIONS NOTED ON DRAWING, LOCATE REPLACEMENT FIXTURES AT HIGHER ELEVATION, CLEAR OF EXISTING CONDUITS THAN EXISTING FIXTURE BEING REMOVED. PROVIDE NEW WIRING TO HIGHER ELEVATION LOCATIONS FROM EXISTING FIXTURE LOCATIONS AS REQUIRED.
- 7. EXISTING CYLINDER FIXTURE TO BE REPLACED WITH NEW CYLINDER. DUE TO MOUNTING RESTRICTIONS, PROVIDE A J. BOX EXTENSION RING AT LOCATION OF EXISTING FIXTURE ATTACHMENT TO BUILDING. BELOW THIS EXTENSION BOX, MOUNT NEW FIXTURE BACKBOX SO THAT TOP OF NEW FIXTURE FITS UNDER EXISTING STRUCTURE. CONFIRM EXACT REQUIREMENTS IN FIELD.
- 8. EXISTING LIGHTING FIXTURE TO REMAIN. CLEAN AND RELAMP WITH NEW LED "A" LAMP TO MATCH EXISTING INCANDESCENT LAMP BASE.

SET ANCHOR BOLTS, FURNISH WITH POLE USING TEMPLATE SUPPLIED BY MANUFACTURER. BOND TO POLE FINISHED GRADE FINISHED GRADE SCHEDULE 40 PVC RIGID STEEL AT 10" O.C.

POLE BASE DETAIL (TYPE "SC" AMD "SF")

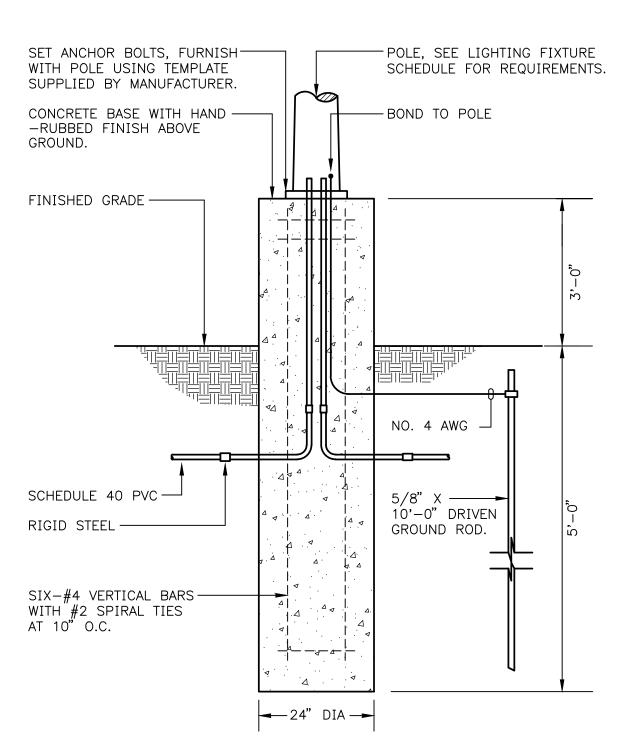

POLE BASE DETAIL
(TYPES "SA", "SB", "SD", "SE")

NO SCALE

				JILDING MOUN REPLACE EE LIGHTING F	MENT SCHED	ULE				
BUILDING	A1 FIXTURES	A2 FIXTURES	A3 FIXTURES	A4 FIXTURES	A5 FIXTURES	B FIXTURES	C FIXTURES	D FIXTURES	E FIXTURES	F FIXTURES
Oakley	3	4	1							
Jere Whitson	1	1					7			
University Services	2						6	9		
Memorial Gym	6	4	6				6			
Bartoo	ļ	1	7				8			
Kittrell	<u> </u>	1	7				8			
Foundation Hall	7	5	13			2				18
Academic Wellness Center	2	1			21					3
Roaden University Center		3	1				8			3
Southwest Hall	1	8								1
T.J. Farr	1	2								
Henderson	1			2			2			
Clement	9		3				2			
Brown	9	1					8			
Prescott	11	1					8			
Bruner	12		3				5			
Maint. CompChilr.		15								
Ware./Garage	6	8								4
Maint. – Carr Bldg.			8						6	
Maint. – Admin.			2						8	
Derryberry	3	1	1				2	6		3
Pennebaker	9						8			
Bryan Fine Arts	8						13			
Spare Fixtures (Turn over to owner)	10	6	8			1	11	5	4	4
TOTALS	100	62	60	2	21	3	102	20	18	35

TYPE C DECORATIVE LANTERN SCHEDULE

TYPE	SIZE	LAMP BASE & TYPE	MANUFACTURER	CATALOG NUMBER	LOCATIONS
SMALL LANTERN, BLACK FINISH	12-¾"H, 6-7/8"W, 8-¾"D	A11 MEDIUM CLEAR LED MAX 13 WATT, 4000 DEGREE K	PROGRESS LIGHTING WESTPORT STYLE	P5862-31	HENDERSON HALL WEST SIDE (2) DERRYBERRY HALL SIDE ENTRANCES (2)
MEDIUM LANTERN, BLACK FINISH	16"H, 9"W, 10−¾8"D	A11 MEDIUM CLEAR LED MAX 13 WATT, 4000 DEGREE K	PROGRESS LIGHTING WESTPORT STYLE	P5863-31	SIDE AND REAR ENTRANCES KITTRELL HALL (6) BARTOO HALL (6)
LARGE LANTERN, BLACK FINISH	19-1⁄4"H, 11" W, 12-7/8"D	TWO (2) CANDLEBRA BASE LED LAMPS 4000 DEGREE K	PROGRESS LIGHTING WESTPORT STYLE	P5864-31	FRONT ENTRANCES (FACING QUAD) KITTRELL HALL (2) BARTOO HALL (2)
LARGE LANTERN #2, BLACK FINISH	21-¾"H, 10-¾"W, 13-½"D	THREE (3) CANDLEBRA BASE LED LAMPS 4000 DEGREE K	PROGRESS LIGHTING VERDAE STYLE	P560016-031	JERE WHITSON (7), MEMORIAL GYM (6), BRYAN FINE ARTS (8), PENNEBAKER (8) BRUNER (5), CLEMENT (2), BROWN (8), PRESCOTT (8)
HANGING LANTERN, BLACK FINISH	OVERALL HT W/CHAIN" 53" $14-\frac{1}{16}$ "H, $9-\frac{3}{8}$ " DIAMETER	A11 MEDIUM CLEAR LED MAX 13 WATT, 4000 DEGREE K	PROGRESS LIGHTING WELBOURNE STYLE	P5582-31	BRYAN FINE ARTS WHERE HANGING (TOTAL OF FIVE)
LARGE LANTERN #3, BLACK FINISH	24-¾"H, 14"W, 18-1⁄8"D	A11 MEDIUM CLEAR LED MAX 13 WATT, 4000 DEGREE K	PHILIPS LIGHTING	MANOR SERIES 5510-BLK-C-D- 100I-E-N-N	ROADEN UNIVERSITY CENTER (8) UNIVERSITY SERVICES BUILDING (6)


AGRICULTURE

OF TENNESSEE

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Campus Wide Exterior Lighting Upgrad

Tennessee Technological Unive

SBC Project No. 364/011-08-202

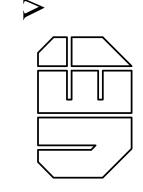Cookeville, Tennessee


DRAWING DESCRIPTION:


LEGEND AND DETAILS

DATE:
AUGUST 18, 2025
REVISIONS:
1 9-10-25

EET NUMBER

E0.1

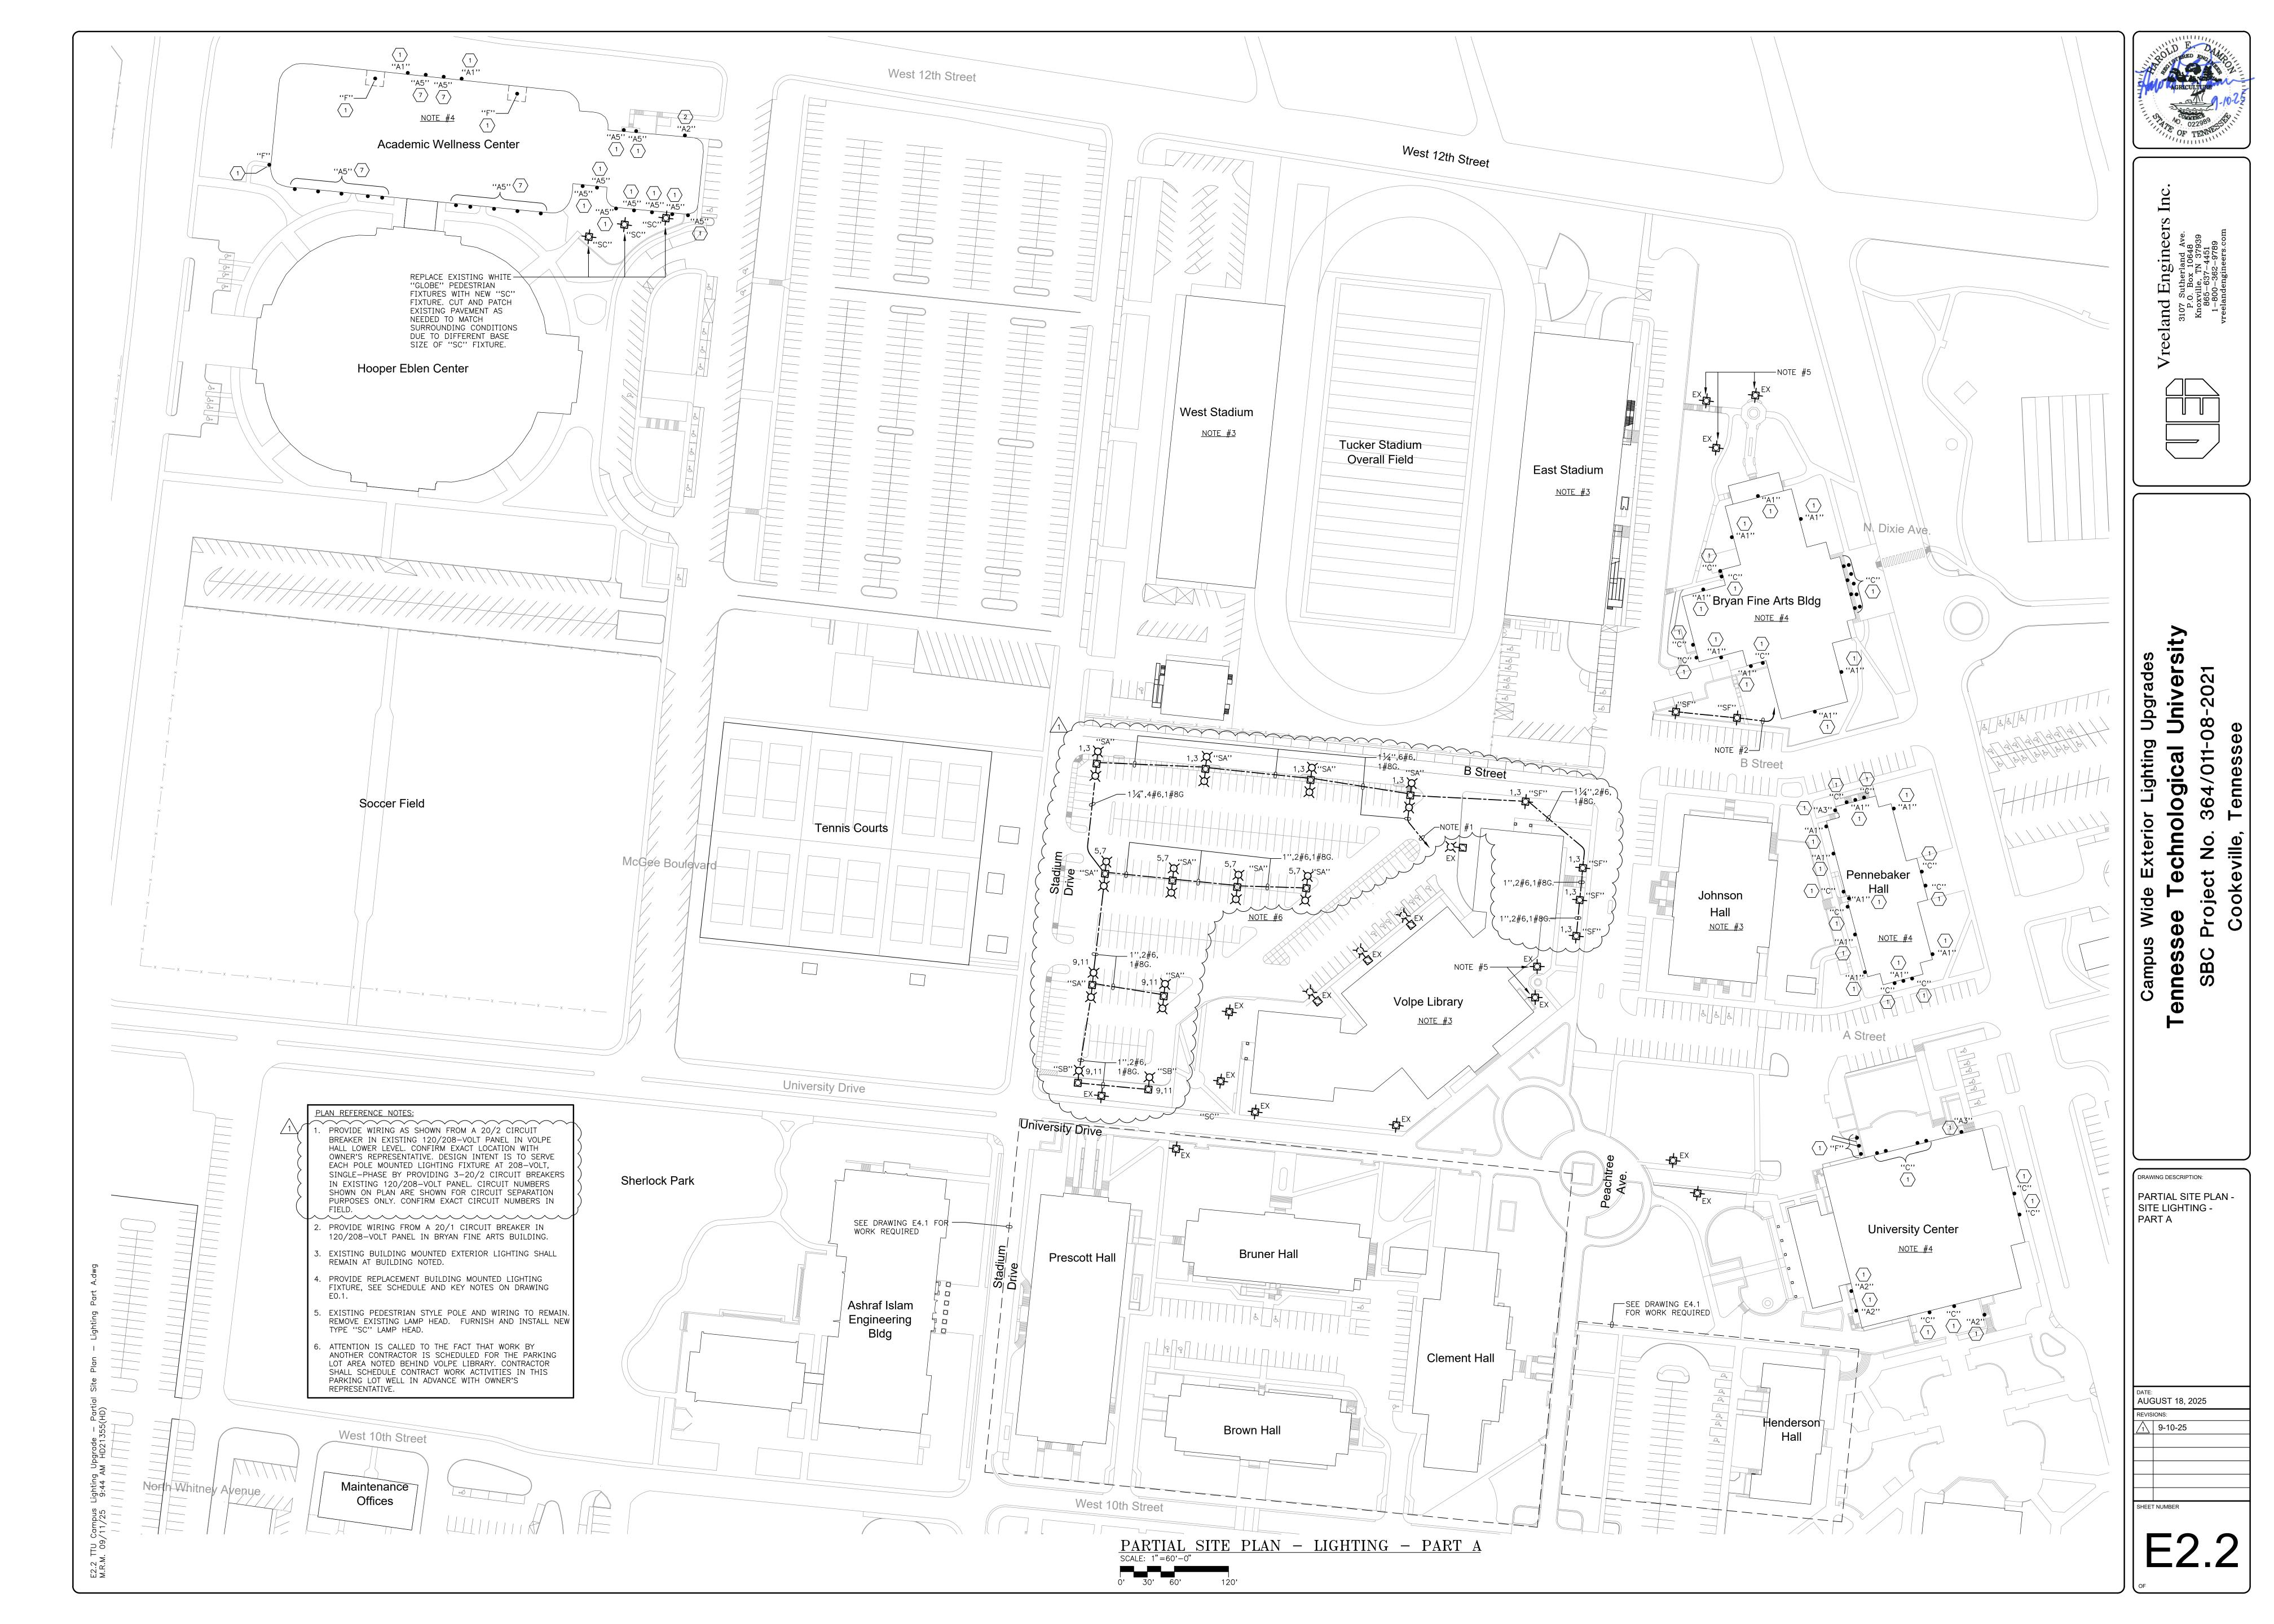

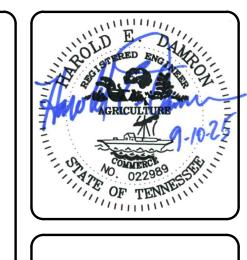

Vreeland E

DRAWING DESCRIPTION:

PARTIAL SITE PLAN -SITE LIGHTING -PART B

DATE:
AUGUST 18, 2025

REVISIONS:

9-10-25

SHEET NUMBER

E3.1



PARTIAL SITE PLAN - LIGHTING - PART B SCALE: 1"=60'-0"

PLAN REFERENCE NOTES:

- FURNISH AND INSTALL A NEW TYPE "SC" LIGHTING FIXTURE ALONG LOWER SIDEWALK AT LOCATION INDICATED. EXTEND 3/4",2#10,1#10G. TO THIS NEW FIXTURE FROM EXISTING CIRCUIT SERVING EXISTING POST TOP SIDEWALK FIXTURE WHERE INDICATED.
- FURNISH AND INSTALL A NEW TYPE "SC" LIGHTING FIXTURE ALONG SIDEWALK AT LOCATION INDICATED. EXTEND 34",2#10,1#10G. TO THIS NEW FIXTURE FROM EXISTING CIRCUIT SERVING EXISTING POST TOP SIDEWALK FIXTURE WHERE INDICATED.
- 6. EXISTING BUILDING MOUNTED EXTERIOR LIGHTING SHALL REMAIN AT BUILDING NOTED.
- . PROVIDE REPLACEMENT BUILDING MOUNTED LIGHTING FIXTURES, SEE SCHEDULE AND KEY NOTES ON DRAWING
- 5. EXISTING PEDESTRIAN STYLE POLE AND WIRING TO REMAIN. REMOVE EXISTING LAMP HEAD. FURNISH AND INSTALL NEW TYPE "SC" LAMP HEAD.


DRAWING DESCRIPTION:

PARTIAL SITE PLAN -SITE LIGHTING -PART E - ADD ALTERNATE NO. 1

DATE:
AUGUST 18, 2025
REVISIONS:
9-10-25

SHEET NUMBER

E6.1

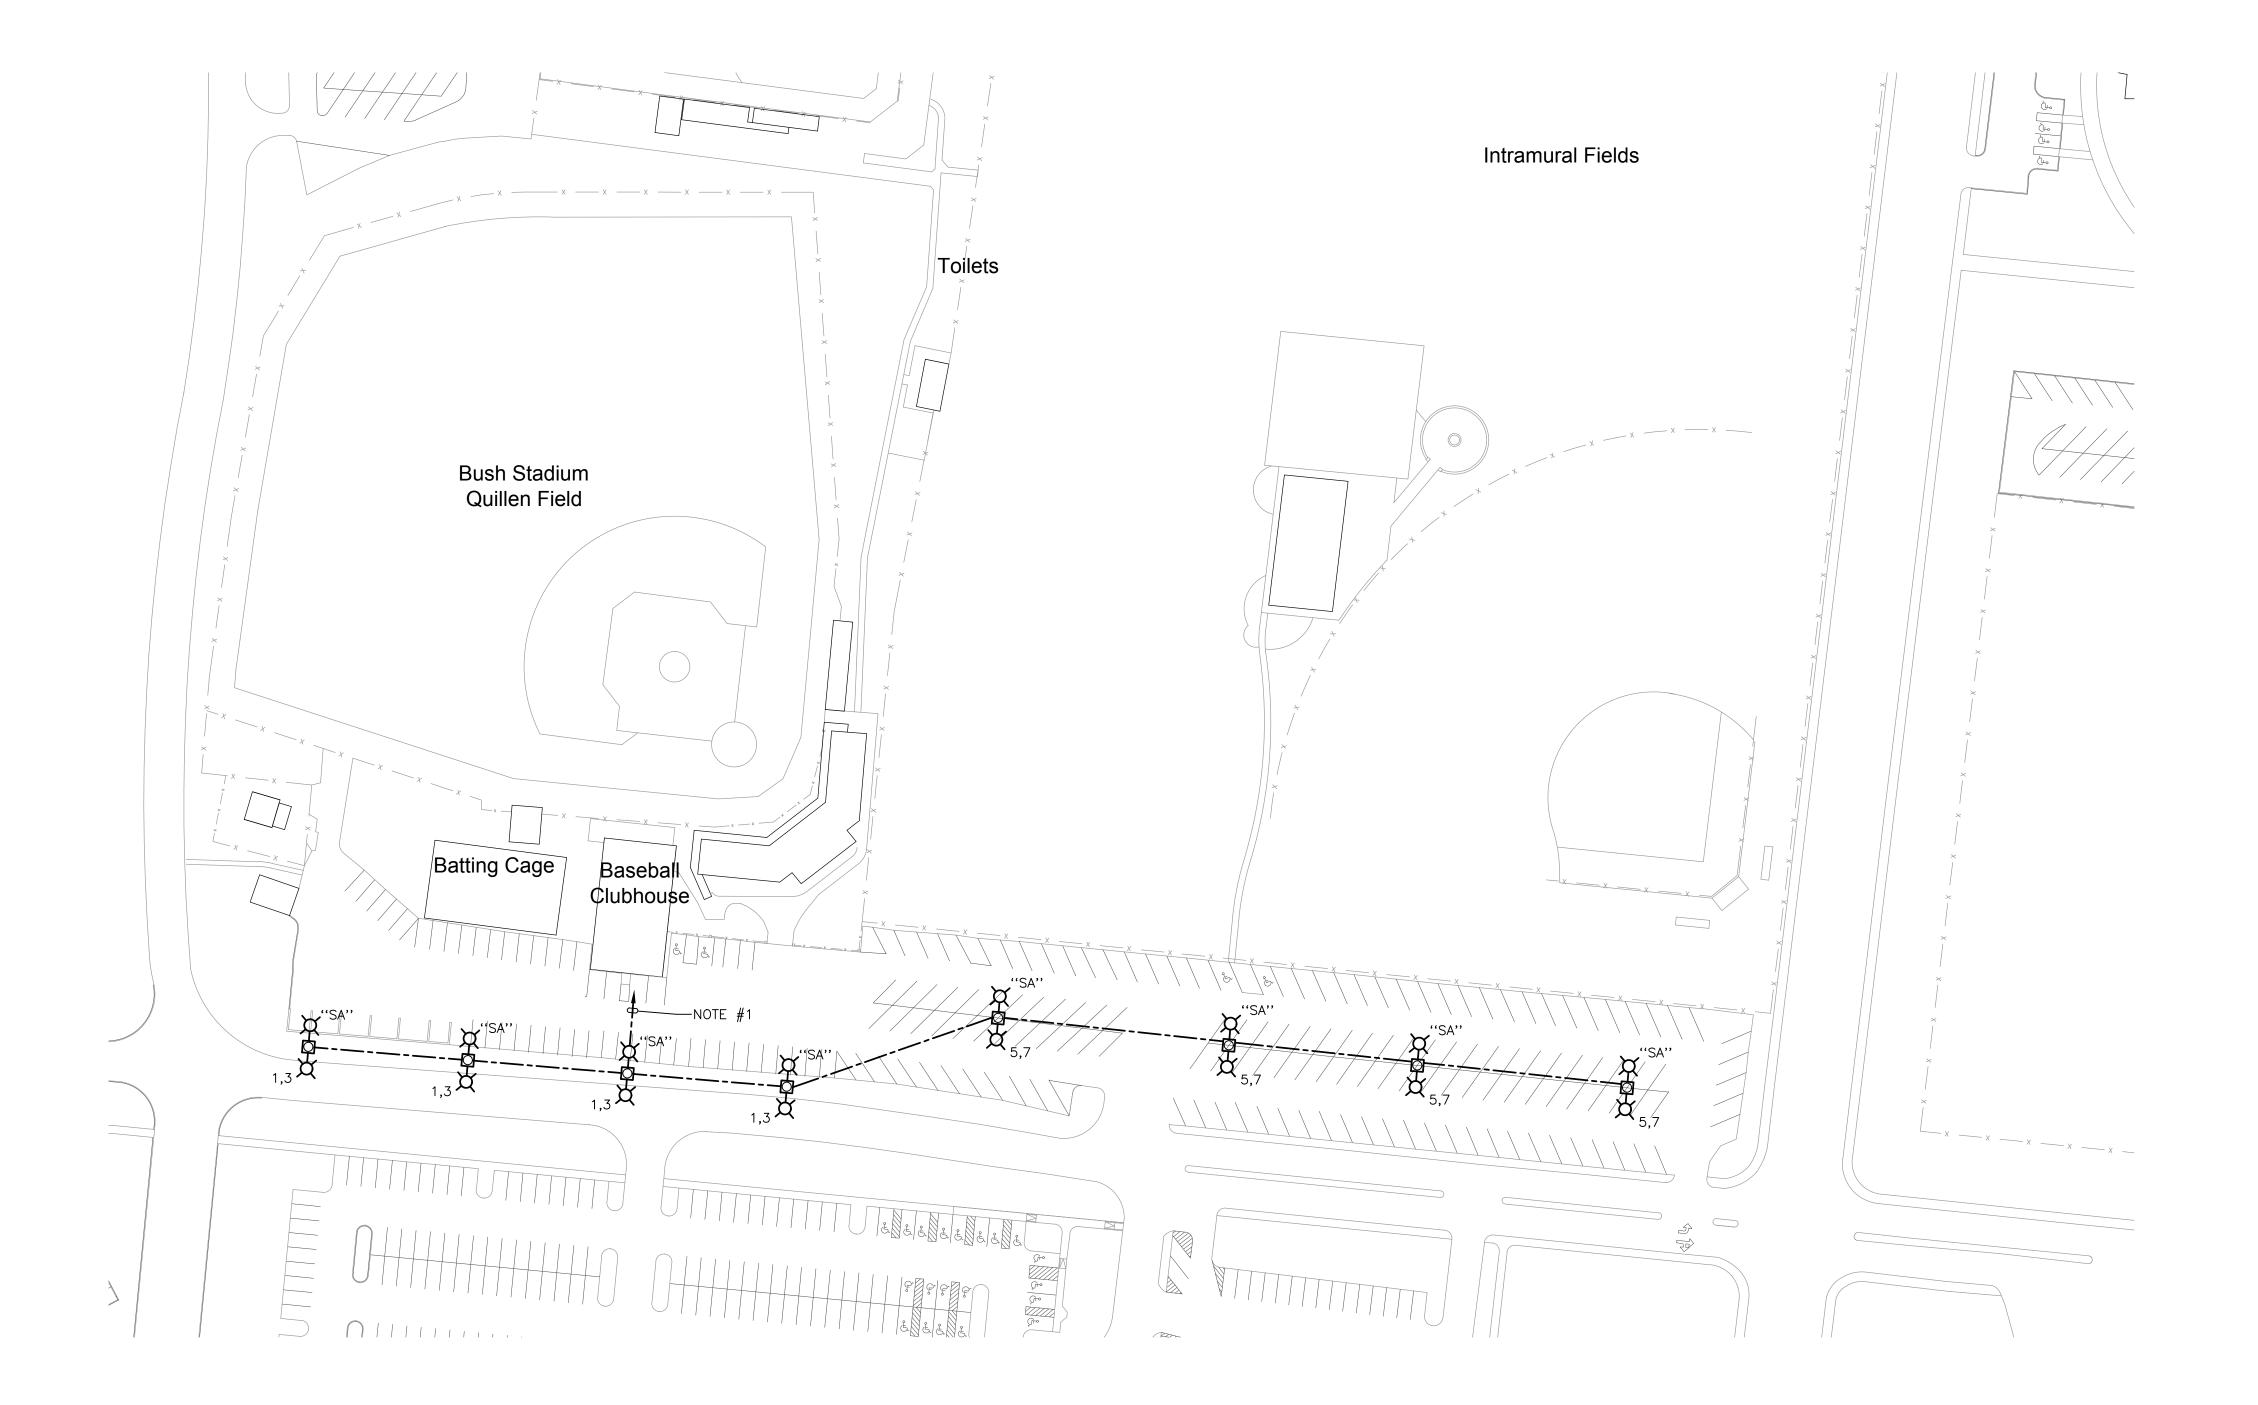

PARTIAL SITE PLAN - LIGHTING - PART E - ADD ALTERNATE NO. 1

SCALE: 1"=60'-0"

PLAN REFERENCE NOTE:

1. EXTEND 1½",4#8,1#10G. FROM EXISTING PANELBOARD IN EXISTING BASEBALL CLUBHOUSE BUILDING TO SERVE NEW POLE MOUNTED LIGHTING FIXTURES INDICATED. FURNISH AND INSTALL 2-20/2 CIRCUIT BREAKERS TO SERVE THESE CIRCUITS. DESIGN INTENT IS TO SERVE THE NEW POLE MOUNTED LIGHTING FIXTURES AT 208-VOLT, SINGLE-PHASE CIRCUIT NUMBERS SHOWN BY LIGHTING FIXTURES ARE SHOWN FOR CIRCUIT SEPARATION PURPOSES ONLY. CONFIRM CIRCUIT NUMBERS IN FIELD. PROVIDE UPDATED TYPEWRITTEN CIRCUIT DIRECTORY REFLECTING CHANGES MADE ON THIS PROJECT. UTILIZE #8 AWG WIRING FOR PHASE CONDUCTORS AND #10 AWG WIRING FOR EQUIPMENT

GROUNDING FOR THE ENTIRE LENGTH OF WIRING RUN.



Vreeland Engineers In

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Campus Wide Exterior Lighting Upgrades

Tennessee Technological Universi

SBC Project No. 364/011-08-2021

DRAWING DESCRIPTION:

PARTIAL SITE PLAN -SITE LIGHTING -PART F

DATE: AUGUST 18, 2025

9-10-25

SHEET NUMBER

E7.1